

SCHEDULE A-4

Permit Application

I/ We hereby apply under Part 14 of the *Local Government Act* for a;

Development Variance Permit

Temporary Use Permit

Development Permit

An Application Fee in the amount of \$ 350 as stipulated in FVRD Application Fees Bylaw No. 1231, 2013 must be paid upon submission of this application.

Civic Address 1777 COLUMBIA VALLEY RD PID _____

Legal Description Lot _____ Block _____ Section 15 Township 22 Range _____ Plan BCS 3022

The property described above is the subject of this application and is referred to herein as the 'subject property.' This application is made with my full knowledge and consent. I declare that the information submitted in support of the application is true and correct in all respects.

Owner's Declaration

Name of Owner (print) <u>AQUABEL CROSSING</u>	Signature of Owner	Date
Name of Owner (print)	Signature of Owner	Date

Owner's Contact Information

Address <u>PO BOX 2267</u>		City <u>CHILLIWACK</u>
Email		Postal Code <u>V2R 1A6</u>
Phone	Cell	Fax <u>604 858 2864</u>

Office Use Only	Date <u>10 MAY 2018</u>	File No. <u>3090-20 2018-22</u>
	Received By <u>J.H.</u>	Folio No. <u>775.02269.051</u>
	Receipt No. <u>5976/4</u>	Fees Paid: \$ <u>350.00</u>

Agent I hereby give permission to _____ to act as my/our agent in all matters relating to this application.

Only complete this section if the applicant is NOT the owner.

Signature of Owner	Date
Signature of Owner	Date

Agent's contact information and declaration

Name of Agent		Company
Address		City
Email		Postal Code
Phone	Cell	Fax

I declare that the information submitted in support of this application is true and correct in all respects.

Signature of Agent	Date
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Development Details

Property Size _____ Present Zoning _____

Existing Use _____

Proposed Development WATER RESERVOIR EXPANSION

Proposed Variation / Supplement ALLOW FOR NEW STRUCTURE TO ENCRACH ON SIDEYARD SETBACK.

(use separate sheet if necessary)

Reasons in Support of Application THIS IS THE ONLY FEASIBLE PLACE TO ADD THE EXPANSION

Provincial Requirements

(This is not an exhaustive list; other provincial regulations will apply)

Riparian Areas Regulation

Please indicate whether the development proposal involves residential, commercial, or including vegetation removal or alteration; soil disturbance; construction of buildings and structures; creation of impervious or semi-pervious surfaces; trails, roads, docks, wharves, bridges and, infrastructure and works of any kind – within:

yes no

30 metres of the high water mark of any water body

yes no

a ravine or within 30 metres of the top of a ravine bank

“Water body” includes; 1) a watercourse, whether it usually contains water or not; 2) a pond, lake, river, creek, or brook; 3) a ditch, spring, or wetland that is connected by surface flow to 1 or 2 above.

Under the *Riparian Areas Regulation* and the *Fish Protection Act*, a riparian area assessment report may be required before this application can be approved.

Contaminated Sites Profile

Pursuant to the *Environmental Management Act*, an applicant is required to submit a completed “Site Profile” for properties that are or were used for purposes indicated in Schedule 2 of the *Contaminated Sites Regulations*. Please indicate if:

yes no

the property has been used for commercial or industrial purposes.

If you responded ‘yes,’ you may be required to submit a Site Profile. Please contact FVRD Planning or the Ministry of Environment for further information.

Archaeological Resources

Are there archaeological sites or resources on the subject property?

yes no I don't know

If you responded ‘yes’ or ‘I don’t know’ you may be advised to contact the Archaeology Branch of the Ministry of Tourism, Sport and the Arts for further information.

Required Information

When providing Application Forms to the applicant, Regional District staff shall indicate which of the following attachments are required for this application. **Additional information may also be required at a later date.**

	Required	Received	Details
Location Map			Showing the parcel (s) to which this application pertains and uses on adjacent parcels
Site Plan At a scale of: 1: _____			Reduced sets of metric plans
			North arrow and scale
			Dimensions of property lines, rights-of-ways, easements
			Location and dimensions of existing buildings & setbacks to lot lines, rights-of-ways, easements
			Location and dimensions of proposed buildings & setbacks to lot lines, rights-of-ways, easements
			Location of all water features, including streams, wetlands, ponds, ditches, lakes on or adjacent to the property
			Location of all existing & proposed water lines, wells, septic fields, sanitary sewer & storm drain, including sizes
			Location, numbering & dimensions of all vehicle and bicycle parking, disabled persons' parking, vehicle stops & loading
			Natural & finished grades of site, at buildings & retaining walls
			Location of existing & proposed access, pathways
			Above ground services, equipment and exterior lighting details
			Location & dimensions of free-standing signs
			Storm water management infrastructure and impermeable surfaces
		Other:	
Floor Plans			Uses of spaces & building dimensions
			Other:
Landscape Plan Same scale as site plan			Location, quantity, size & species of existing & proposed plants, trees & turf
			Contour information (_____ metre contour intervals)
			Major topographical features (water course, rocks, etc.)
			All screening, paving, retaining walls & other details
			Traffic circulation (pedestrian, automobile, etc.)
			Other:
Reports			Geotechnical Report
			Environmental Assessment
			Archaeological Assessment
			Other:

The personal information on this form is being collected in accordance with Section 26 of the *Freedom of Information and Protection of Privacy Act, RSBC 1996 Ch. 165* and the *Local Government Act, RSBC 2015 Ch. 1*. It will only be collected, used and disclosed for the purpose of administering matters with respect to planning, land use management and related services delivered, or proposed to be delivered, by the FVRD. Questions about the use of personal information and the protection of privacy may be directed to the FVRD Privacy Officer at 45950 Cheam Avenue, Chilliwack, BC V2P 1N6, Tel: 1-800-528-0061 FOI@fvrd.ca.



LETTER OF AUTHORIZATION

Registered Authority

Please be advised that I/we, BCS3022 THE COTTAGES AT CULTUS LAKE
(Print names of ALL Registered Owners or Corporate Director)

Representing, _____
(Corporate name - if applicable)

am/are the registered owner(s);

Site Civic Address: 1777 COLUMBIA VALLEY RD

Lot# _____ Block _____ Plan _____ PID# _____

SEC 15, TOWNSHIP 22 NEW WEST DIST
STRATA PLAN BCS 3022

Appointed Authorized Agent

Name of Authorized Agent AQUADEL CROSSING LTD.

Company Name _____

Mailing Address PO BOX 2267, CHILLIWACK, BC V2P 1A6.

City: Chilliwack Postal Code: V2P 1A6.

Email: _____

Phone: _____

Signature of Authorized Agent X

Permission to act:

As my/our Authorized Agent in the matter of the following:

- to view and obtain copies of all plans and permits
- to apply for and obtain building permits for proposed construction to the above reference Civic Address
- to apply for Planning File: Development Permit Development Variance Permit Subdivision
- other: CORIX WATER TANK EXPANSION BLDG PERMIT ON

CORIX R/W ONLY

THIS LETTER OF AUTHORIZATION EXPIRES SEPT. 1, 2018.

Authorized Signature (Registered Owner or Corporate Director)

This document shall serve to notify the Fraser Valley Regional District that I am/we are the legal owner(s) of the property described above and do authorize the person indicated above ("Authorized Agent") to act on my/our behalf on all matters indicated above ("Permission to act") for the above referenced property. In addition, I/we have read and understand the above application and authorize the Authorized Agent to sign the above on my/our behalf.

X [Signature]

Sign KARON WEVER

Print _____

Date: 04-13-18

X _____

Sign _____

Print _____

Date: _____

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Building Department
Fraser Valley Regional District
1-45950 Cheam Avenue
Chilliwack, BC V2P 1N6

April 13, 2018
Project: 17-241

Re: Aquadel Crossing Water Reservoir Expansion
31859 Gabriola Court, Abbotsford, BC

This letter is to confirm that in our structural design of the reservoir expansion, the effects of the following noted items were taken into account, including any impacts on the existing tank structure:

- Additional weights of the new structure and design loadings
- The new openings in the existing walls to allow water passage between the new and existing.

The specified sizes and locations of the new openings do not require additional reinforcing of the existing tank structure. The structural integrity of the existing tank is not compromised by the proposed reservoir expansion as detailed on our drawings.

We trust the above meets your requirements and understanding. If you have any questions, please contact the undersigned.

Sincerely,
van den Brink Engineering Ltd.



Ivan van den Brink, P.Eng., Struct. Eng.



Owner(s) Acknowledgement of Responsibility

Re: Property Address: 1777 COLUMBIA VALLEY RD

Legal Description: SECTION 15, TOWNSHIP 22, NEW WESTMINSTER DISTRICT, STRATA PLAN BCS3022,

Permit #: BP014215 - (Water Reservoir Expansion)

This undertaking is given by the undersigned, as the **owner(s)** of the property described above, with the intention that it be binding on the **owner(s)** and that the **Regional District** will rely on same.

I/We confirm that I/we have applied for a permit pursuant to Fraser Valley Regional District Building Bylaw No. 1188, 2013 and that I/we have carefully reviewed and fully understand all of the provisions of the Bylaw and in particular understand, acknowledge and accept the provisions describing the purpose of the Bylaw, the conditions under which permits are issued, the disclaimer of warranty or representation and the limited extent of the scope of the Bylaw and inspections there under.

Without in any way limiting the foregoing, I/we acknowledge fully that it is my/our responsibility, whether or not any work to be performed pursuant to the permit applied for is done by me/us, my/our **agent**, a contractor or a **registered professional** to ensure compliance with the **Building Code** and the Bylaw.

I/we am/are not in any way relying on the **Regional District** or the **Building Official** to protect the **owner(s)** or any other persons as set out in the Bylaw and I/we will not make any claim alleging any such responsibility or liability on the part of the **Regional District** or its **Building Official**.

Owner(s) Information:

Name: CORIX MULTI-UTILITY SERVICES (CMUS)

Address: 19900 84TH AVE LANGLEY BC V2Y3C2

Signature: [Signature] - BOB SHIELDS ON BEHALF OF CMUS

Date: MAY 2, 2018.

The personal information on this form is being collected in accordance with Section 27 of the *Freedom of Information and Protection of Privacy Act, RSBC 1996 Ch. 165* and Part 9, Division 1 of the *Local Government Act, RSBC 2015 Ch. 1* and regulations *thereto*. The personal information collected on this form will only be collected, used and disclosed for the purposes of administering matters with respect to Building Regulation. Questions with respect to the collection, use and disclosure of the personal information being collected on this form may be directed to the Fraser Valley Regional District Privacy Officer and Head of Freedom of Information and Privacy at 45950 Cheam Avenue, Chilliwack, BC V2P 1N6; by telephone at 604-702-5000 or toll free at 1-800-528-0061; or by email to FOI@fvrd.ca.



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File Number: 3800-30-BP014215H

4 April 2018

AQUADEL CROSSING LTD
PO BOX 2267
CHILLIWACK, BC V2R 1A6

Dear sir:

Re: Building Permit Application No. BP014215 for the purposes of constructing a Water Reservoir Expansion on property legally described as SECTION 15, TOWNSHIP 22, NEW WESTMINSTER DISTRICT, STRATA PLAN BCS3022, 1777 COLUMBIA VALLEY RD

In connection with the above referenced application, an inspection of the proposed site carried out on **4 April 2018** indicated that the proposed construction would be on land which may be subject to certain geotechnical hazards. Therefore, pursuant to Section 56 of the Community Charter (2003, SBC Chap 326), in order to have your building permit application processed further, you are required to submit a report from a qualified professional which certifies that the land may be used safely for the use intended. This report may then have to be registered on the title of the subject property before the building permit is issued.

I enclose some guidance notes to assist you in this matter. Please note that it is important that your qualified professional contacts <PLANNER> in the Regional District Planning Department before commencing any work on the report.

If you require any clarification or further information regarding this matter, please contact me at your convenience.

Yours sincerely,

Mike
Foster

Mike Foster
Building Inspector.

Digitally signed by Mike Foster
DN: cn=Mike Foster, o=Fraser
Valley Regional District,
ou=Building and Bylaw,
email=mfoster@fvrd.ca, c=CA
Date: 2018.04.04 10:52:02
-07'00'



4 April 2018

File Number: 3800-30-BP014215H

AQUADEL CROSSING LTD
PO BOX 2267
CHILLIWACK, BC V2R 1A6

SENT VIA EMAIL TO: wendyb@genicadev.com

Dear Sir or Madam:

Re: Building Permit Application on property at 1777 COLUMBIA VALLEY RD

Building Permit Application Number:	BP014215
Proposed works:	Water Reservoir Expansion
Legally described as:	SECTION 15, TOWNSHIP 22, NEW WESTMINSTER DISTRICT, STRATA PLAN BCS3022, DUMMY FOLIO FOR COMMON PROPERTY PROPERTY MANUALLY ADDED BY FVRD, NOT ON BCA ROLL.
Parcel Identifier (PID):	

Thank you for submitting a building permit application on Feb 14, 2018 for the project referenced above. Building permits benefit you and your neighbours in many ways. They ensure buildings are safe for you, your family and visitors. They support higher market value for your property by increasing buyer confidence. They reduce your insurance costs because insurers know the building meets the BC Building Code, and building permits reduce lifecycle repair and maintenance costs by ensuring the building is efficient and well-built. Not only do building permits provide value to you, they also benefit your neighbours by enhancing the overall safety and quality of your neighbourhood.

Professional builders know the process inside and out. However, most people only experience building permitting a few times in their lives so it can be challenging. We carefully reviewed your application and have prepared the checklist below to guide you. Whether you are a pro or a first-timer, this checklist will help you get your building permit quickly and efficiently.

PLANNING REQUIREMENTS

1. Development Variance Permit - The proposed Water Reservoir Expansion does not comply with Area H Zoning Bylaw No. 66 due to the encroachment on the side setback. Please revise your plans to meet FVRD bylaw requirements. If you cannot meet the requirements because of unique conditions on your property, please contact FVRD Planning to discuss the possibility of a Development Variance Permit. Call 604-702-5000 or email planning@fvrd.ca.

Check When Complete



2. **GeoHazard Report** - The proposed structure may be subject to a geotechnical hazard due to Land slip. To protect your safety, a report and a Hazard Assurance Statement from a geotechnical engineer is required that states that the Water Reservoir Expansion will be safe for its intended use. The report will be registered on your property title as a Covenant. A Covenant can take time but there are a couple of things you can do to speed it up:

- **Lawyer / notary contact.** Provide us with contact information for the notary or lawyer who will handle the covenant for you.
- **Priority Agreement.** If your property title includes a mortgage or other financial charge, your financial institution will need to sign a Priority agreement. Contact your financial institution about this early on to avoid delays.

time to

Questions & Contacts. Detailed info on property development can be found on our web site at www.fvrd.ca. Contact FVRD Planning staff at 604-702-5000 or planning@fvrd.ca.

BUILDING REQUIREMENTS

3. **Engineering Design – BC Building Code** - Please submit the following information prepared by a *Registered Professional of Record*:

- a) Structural Engineers (Van Den Brink) sealed letter stating that the new holes into the existing tank will not lower the current level of structural integrity of the tank and further detail on how the tank will be reinforced, if necessary to maintain its integrity. This is needed to meet the requirements of the BC Building Code.

today

A Registered Professional of Record is a person who is may practise as an Architect under the Architects Act, or a person who is may practise as a Professional Engineer under the Engineers and Geoscientists Act.

4. **Letter of Authorization from the Registered Property Owner(s)** - Written confirmation from all property owners registered on the title of the property is required to authorize the application. Please have Strata Corporation BCS3022 or Corix Utilities complete and submit the attached form for Aquadel Crossing Ltd.


early

5. **Owners Acknowledgement of Responsibility** - Please provide written confirmation from all property owners registered on the title of the property to acknowledge responsibility for the proposed construction. Please have Strata Corporation or Corix Utilities complete and submit the attached "Owners Acknowledgement of Responsibility" form.

early

Once you have submitted all of the items identified in the checklist above, we will review your building plans and move on to the next steps of the permitting process. This may require additional information or clarification. Our goal is to issue your permit within four weeks of receiving a complete application. If you provide complete and timely information we can often do it more quickly.

SITE PLAN.

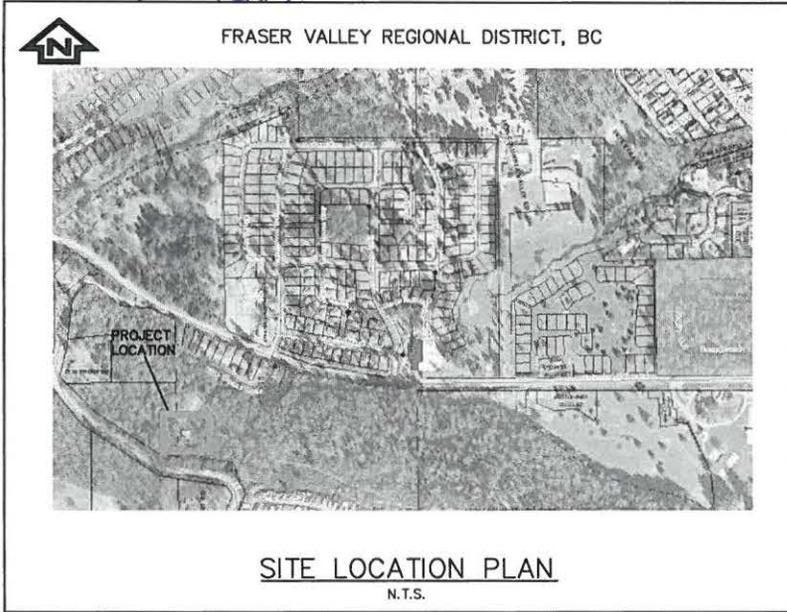

Drawing Index: Rev #3

Drawing No.	Revision	Title of Drawing
		COVER SHEET
C16-5365/D-01	C	STANDARD NOTES
C16-5365/D-02	C	WATER SYSTEM CONTEXT PLAN
C16-5365/D-03	C	RESERVOIR SITE PLAN
C16-5365/D-04	C	RESERVOIR GRADING & WATER DETAILS

DRAWING INDEX
REVISION #3

Project No: C16-5365/D
Date: APRIL 2018
ISSUED FOR BUILDING PERMIT



LOCAL GOVERNMENT FILE: SUB

Client:

AQUADEL CROSSING JOINT VENTURE

Project:

AQUADEL CROSSING
WATER RESERVOIR EXPANSION
1777 COLUMBIA VALLEY ROAD

Engineering Services Provided by:



WEDLER
ENGINEERING

www.wedler.com

THE WEDLER GROUP

- Abbotsford
1.604.746.0300
- Chilliwack
1.604.792.0651
- Courtenay
1.250.334.3263
- Surrey
1.604.588.1919



PROPOSED TIE-IN LOCATION TO THE EXISTING LINDELL BEACH WATER SYSTEM
 PROPOSED PRESSURE REDUCING STATION (PRV) LOCATION
 WATERMAIN CAPPED OFF FOR FUTURE LINDELL BEACH EXTENSION
 WATERMAIN CAPPED OFF FOR POSSIBLE FUTURE WATERMAIN EXTENSION

LINDELL AVE

PROPOSED HYDRANT LOCATIONS AND COVERAGE AREAS (TYP.)

EXISTING LINDELL BEACH WELL

AQUADEL GARDENS PHASE 2 - 22 LOTS

AQUADEL GARDENS PHASE 3 - 36 LOTS (FUTURE)

AQUADEL GARDENS PHASE 1 - 45 LOTS

EXISTING GROUNDWATER WELL SOURCE

AQUADEL GARDENS WATER TIE-IN

ACCESS RD

TREEHOUSE TR

RAVENWOOD TR

COLUMBIA VALLEY RD

DISTRIBUTION TO COTTAGES DEVELOPMENT (TYP.)
 EXISTING WATER BOOSTER PUMP STATION (APPROXIMATE)
 PROPOSED RESERVOIR EXPANSION
 EXISTING RESERVOIR

REV	DESCRIPTION	YYYY-MM-DD	BY	REV	DESCRIPTION	YYYY-MM-DD	BY
A	ISSUED FOR PERMITTING	2016-01-10	AKJ				
B	ISSUED FOR TENDER	2016-02-01	AKJ				
C	ISSUED FOR BUILDING PERMIT	2016-04-30	AKJ				

PROJ. NO.	47
DESIGN/TEAM	AKJ
PREP. REVISION	
NOM. SCALE	1:2500
NET. SCALE	




- TYPE: VERTICAL CHECKLIST
- ADDRESS/ROAD 1,806,746,000
 - CHAIN/CURVE 1,806,742,061
 - COORDINATE 1,200,334,323
 - SURVEY 1,806,546,145

AQUADEL CROSSING JOINT VENTURE	
WATER RESERVOIR EXPANSION	
1777 COLUMBIA VALLEY ROAD, LINDELL BEACH, BC	
WATER SYSTEM CONTEXT PLAN	

DRAWING NO.	OF	-4-
C16-5365/D-02		
LOCAL GOVERNMENT FILE -FILE-		
PHASE	REVISION	C

K:\33003365\C16-5365 - Aquadel Phase 1\Design\Plan\C16-5365-D-02.dwg 2016/04/30 04:02:53 PM ajaram

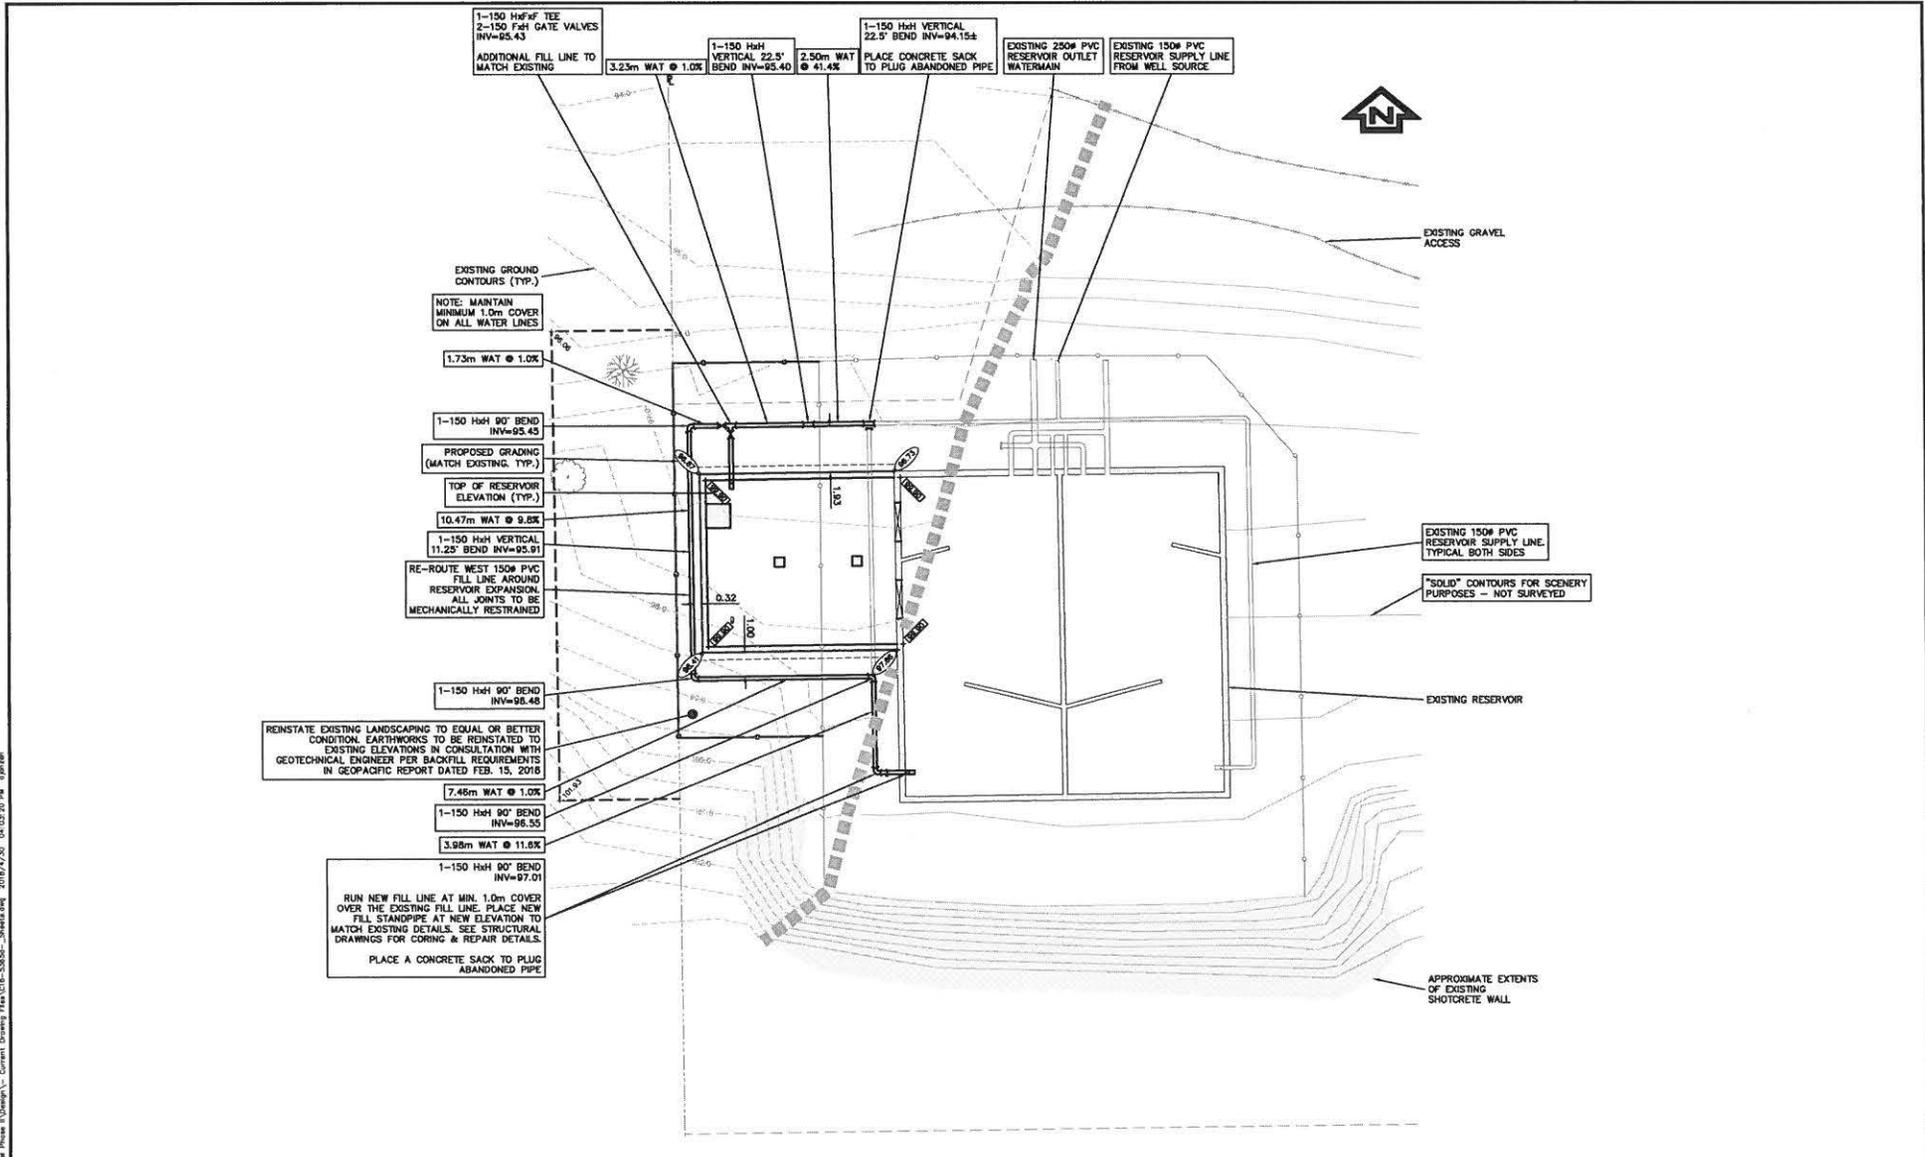

1-150 HxH Tee
2-150 FxH Gate Valves
INV=95.43
ADDITIONAL FILL LINE TO
MATCH EXISTING

3.23m WAT @ 1.0%

1-150 HxH VERTICAL 22.5'
BEND INV=95.40

2.50m WAT @ 41.4%

1-150 HxH VERTICAL 22.5'
BEND INV=94.15±
PLACE CONCRETE SACK
TO PLUG ABANDONED PIPE

EXISTING 250# PVC
RESERVOIR OUTLET
WATERMAIN

EXISTING 150# PVC
RESERVOIR SUPPLY LINE
FROM WELL SOURCE



EXISTING GRAVEL
ACCESS

EXISTING GROUND
CONTOURS (TYP.)

NOTE: MAINTAIN
MINIMUM 1.0m COVER
ON ALL WATER LINES

1.73m WAT @ 1.0%

1-150 HxH 90° BEND
INV=93.43

PROPOSED GRADING
(MATCH EXISTING TYP.)

TOP OF RESERVOIR
ELEVATION (TYP.)

10.47m WAT @ 9.8%

1-150 HxH VERTICAL
11.25' BEND INV=95.91

RE-ROUTE WEST 150# PVC
FILL LINE AROUND
RESERVOIR EXPANSION
ALL JOINTS TO BE
MECHANICALLY RESTRAINED

1-150 HxH 90° BEND
INV=96.48

REINSTATE EXISTING LANDSCAPING TO EQUAL OR BETTER
CONDITION. EARTHWORKS TO BE REINSTATED TO
EXISTING ELEVATIONS IN CONSULTATION WITH
GEO/TECHNICAL ENGINEER PER BACKFILL REQUIREMENTS
IN GEOPACIFIC REPORT DATED FEB. 15, 2018

7.46m WAT @ 1.0%

1-150 HxH 90° BEND
INV=96.55

3.98m WAT @ 11.6%

1-150 HxH 90° BEND
INV=97.01

RUN NEW FILL LINE AT MIN. 1.0m COVER
OVER THE EXISTING FILL LINE. PLACE NEW
FILL STANDPIPE AT NEW ELEVATION TO
MATCH EXISTING DETAILS. SEE STRUCTURAL
DRAWINGS FOR CORING & REPAIR DETAILS.
PLACE A CONCRETE SACK TO PLUG
ABANDONED PIPE

EXISTING 150# PVC
RESERVOIR SUPPLY LINE.
TYPICAL BOTH SIDES

"SOLID" CONTOURS FOR SCENERY
PURPOSES - NOT SURVEYED

EXISTING RESERVOIR

APPROXIMATE EXTENTS
OF EXISTING
SHOTCRETE WALL

DESIGN/DATE	A	ISSUED FOR PERMITTING	2018-01-10	AMJ			
	B	ISSUED FOR TENDER	2018-02-21	AMJ			
	C	ISSUED FOR BUILDING PERMIT	2018-04-20	AMJ			
REV		DESCRIPTION	YYYY-MM-DD	BY	REV	DESCRIPTION	YYYY-MM-DD






PROJ. NO.	217
DESIGN/DATE	AMJ
PROJ. REVIEWED	
NORTH SCALE	1:100
VERT. SCALE	

WEDLER ENGINEERING
www.wedler.com

TYPE: WATER RESERVOIR
 ■ Abbotford 1,804,746,030
 ■ Coquitlam 1,804,792,001
 ■ Courtenay 1,700,704,523
 ■ Surrey 1,804,584,194

AQUADEL CROSSING JOINT VENTURE	
WATER RESERVOIR EXPANSION	
1777 COLUMBIA VALLEY ROAD, LINDELL BEACH, BC	
RESERVOIR GRADING & WATER DETAILS	

DRAWING NO.	OF -4-
C16-5365/D-04	
LOCAL GOVERNMENT FILE	-FILE-
PHASE	REVISION C

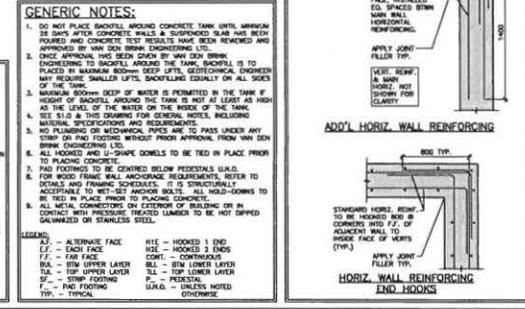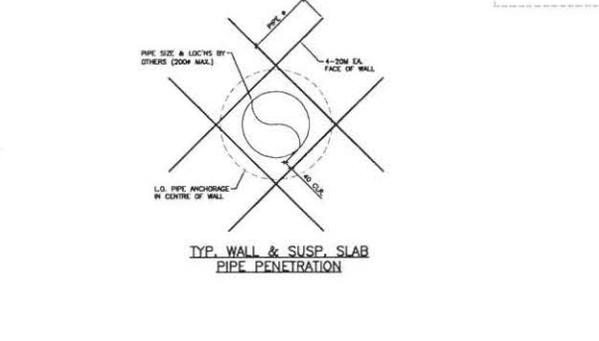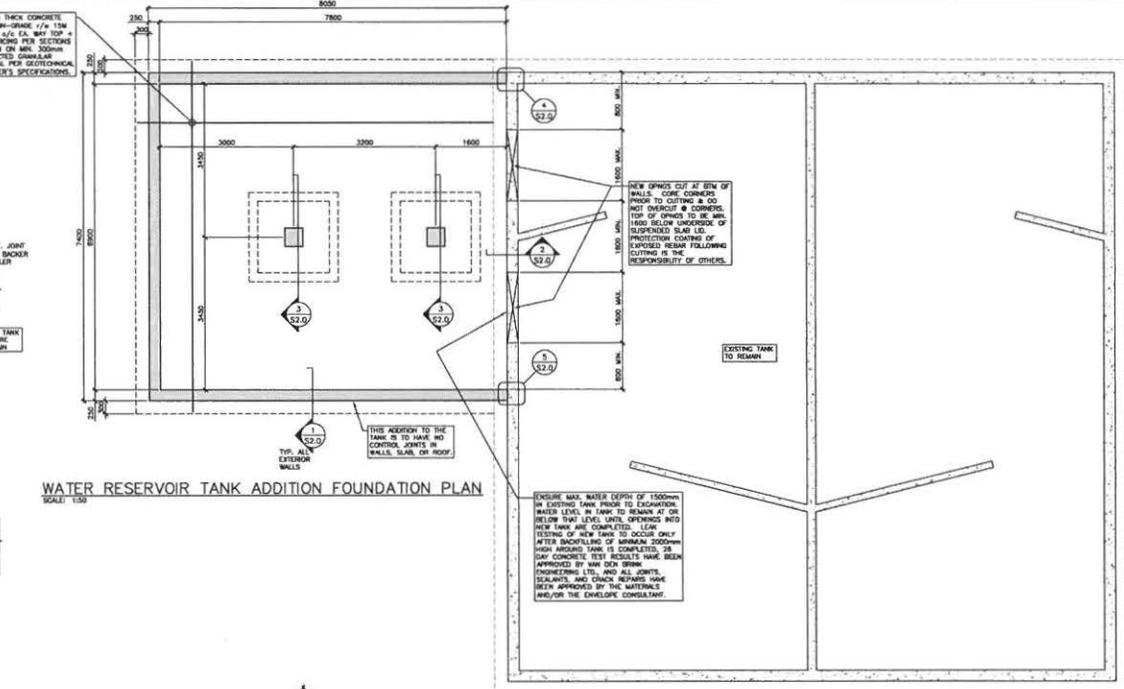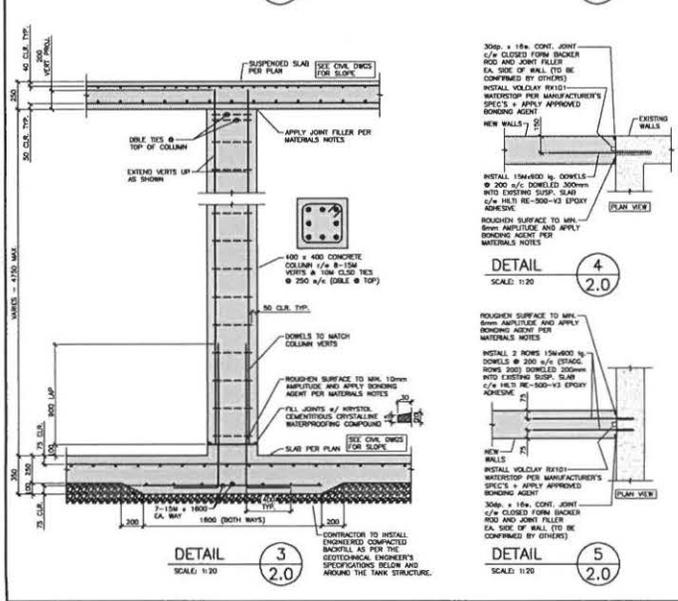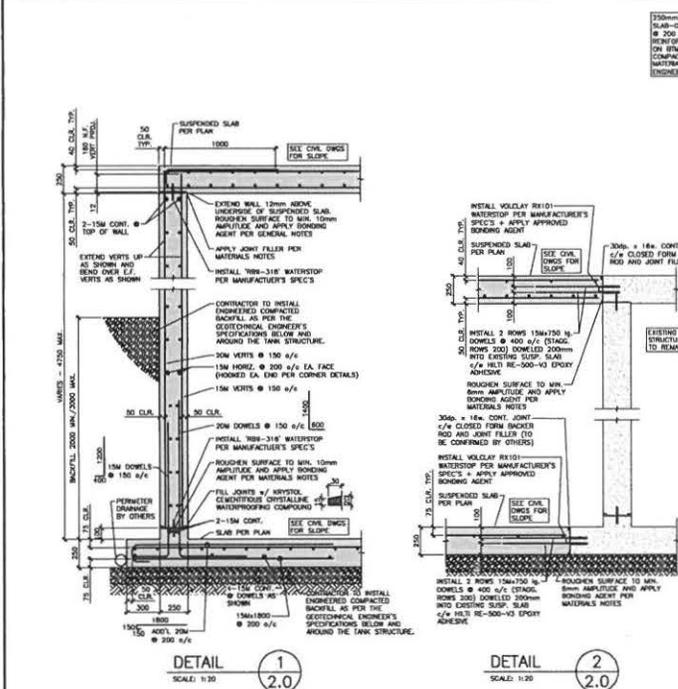

GENERIC NOTES:

- DO NOT PLACE BACKFILL AROUND CONCRETE TANK UNTIL APPROX 28 DAYS AFTER CONCRETE WALLS & SUSPENDED SLAB HAS BEEN REMOVED AND CONCRETE TEST RESULTS HAVE BEEN REVIEWED AND APPROVED BY VAN DEN BRINK ENGINEERING LTD.
- CONCRETE BACKFILL TO BE PLACED IN MAXIMUM 300mm DEEP LIFTS. GEOTECHNICAL ENGINEER MAY REQUIRE SMALLER LIFTS. BACKFILLING EQUALLY ON ALL SIDES OF THE TANK.
- MAINTAIN ROOMS DEEP OF WATER IS PERMITTED IN THE TANK IF HEIGHT OF BACKFILL AROUND THE TANK IS NOT AT LEAST AS HIGH AS THE LEVEL OF THE WATER ON THE INSIDE OF THE TANK.
- SEE S1.0 & T1.0 DRAWING FOR GENERAL NOTES, INCLUDING MATERIAL SPECIFICATIONS AND REQUIREMENTS.
- NO PLUMBING OR MECHANICAL PIPES ARE TO PASS UNDER ANY STRIP OF FIBRE FIBRE REINFORCED POLYMER FROM VAN DEN BRINK ENGINEERING LTD.
- ALL HOOKED AND L-SHAPE DOWELS TO BE TIED IN PLACE PRIOR TO PLACING CONCRETE.
- FOR ROOF FRAME WALL ANCHORAGE REQUIREMENTS REFER TO DETAILS AND FRAMING SCHEDULES. IT IS CONSIDERED ACCEPTABLE TO SET-SET ANCHOR BOLTS. ALL HOOK-DOWNS TO BE TIED IN PLACE PRIOR TO PLACING CONCRETE.
- ALL METAL CONNECTORS ON EXTERIOR OF BUILDING OR IN CONTACT WITH PRESSURE TREATED LUMBER TO BE HOT DIPPED GALVANIZED OR STAINLESS STEEL.

LEGEND:

AL	- ALTERNATE FACE	H1	- HOOKED 1 END
EF	- EXISTING FACE	H2	- HOOKED 2 ENDS
FF	- FINISH FACE	CO	- CONTINUOUS
BL	- 10% UPPER LAYER	BL	- 10% LOWER LAYER
TL	- TOP UPPER LAYER	TL	- TOP LOWER LAYER
F	- FIBRE FOOTING	U	- UNDESIGNATED
F	- FIBRE FOOTING U.L.D.	- UNLESS NOTED OTHERWISE	

TYP. - TYPICAL

DRAWING INDEX:

S1.0	GENERAL NOTES
S2.0	FOUNDATION PLAN, NOTES & DETAILS
S3.1	WATER RESERVOIR SUSPENDED SLAB PLAN & NOTES

3	MAR 28, 2018	ISSUED FOR CONSTRUCTION
2	FEB 25, 2018	ISSUED FOR PROVISIONS
1	DEC 18, 2017	ISSUED FOR PERMIT
NO.	DATE	DESCRIPTION
		ISSUE

van den Brink
 ENGINEERING LTD.
 101 - 3888 AIRPORT ROAD
 CHILLIWACK, B.C. V0P 1A3
 TEL: 604-792-7268
 FAX: 604-793-2220

PROJECT:
AQUADEL CROSSING WATER RESERVOIR EXPANSION

1785 COLUMBIA VALLEY ROAD
 LUNELL BEACH, B.C.

DRAWING TITLE:
WATER RESERVOIR TANK ADDITION FOUNDATION PLAN, NOTES, & DETAILS

PROJECT NO.: 17-241

SCALE: AS NOTED


DRAWN: DYLAN BOLLERS

CHECKED: VAN VAN DEN BRINK


DATE: MARCH 01, 2018

DRAWING NO.: 2.0


3

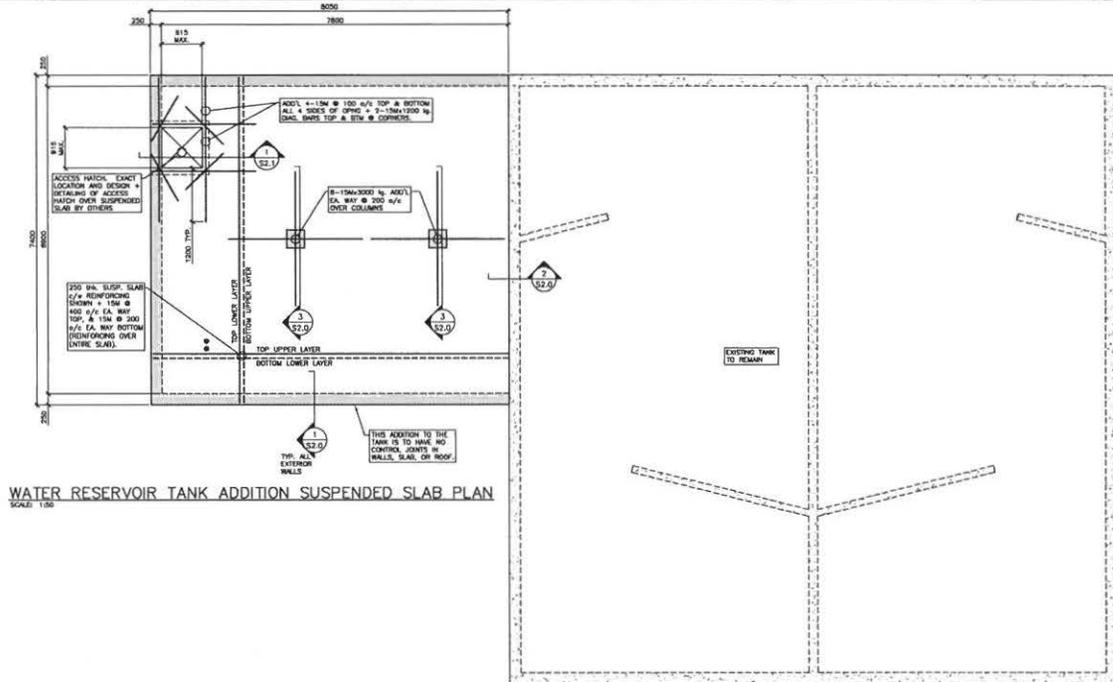

WATER RESERVOIR TANK ADDITION SUSPENDED SLAB PLAN
SCALE: 1:50

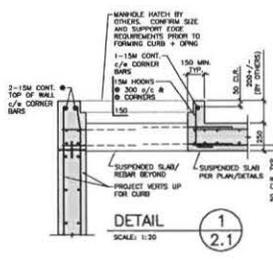

DETAIL 1
SCALE: 1:30

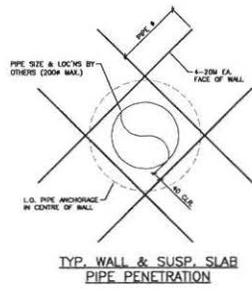

MATERIALS SPECIFICATIONS:
ALL MATERIALS & WATERPROOFING NOTES IN THIS SECTION & IN DETAILS TO BE REVIEWED AND APPROVED BY THE MATERIALS CONSULTANT AND ENVELOPE CONSULTANT. VAN DEN BRINK ENGINEERING LTD. IS NOT RESPONSIBLE FOR ANY DESIGN OR SPECIFICATIONS RELATED TO WATERPROOFING OR MATERIALS.
BRIDGE AGENT - APPLY 'Sika TOP ARMATRE' 110 EPOXY TO THE FOLLOWING JOINTS:
-STARTER WALL TO WALL (AT BASE OF EXTERIOR WALLS)
-WALLS TO SUSPENDED SLAB
FORM TE HOLES: APPLY 'THORNIC' PLUS TO ALL FORM TE HOLES AFTER PLASTIC CONES HAVE BEEN REMOVED. PLUS TO BE APPLIED PRIOR TO SURFACE SEALANT APPLICATION.
JOINT SEALANTS - APPLY 'Sika FLEX 1A' FILLER TO THE FOLLOWING:
-SLAB-ON-CORNER AND WALL CONTROL JOINTS
-STARTER WALL TO WALL
-ALL WALL CORNERS
-WALL TO SUSPENDED SLAB
APPLY 1 COAT OF 'Sika CONCENTRATE' AND ONE COAT OF 'Sika FLEX' AS PER MANUFACTURER'S SPECIFICATIONS TO ALL WOOD SURFACES ON APPROVAL. EQUALLY, ALTERNATELY, AND TYPES JOINTS C-500' TO CONCRETE AS PER MANUFACTURER'S SPECIFICATIONS.
FORM TIES TO BE 'DUPON BROUWERS' PRODUCTS AND USED AS FOLLOWS:
-4-4 HEX SHANK TIE IN 200mm THICK WALLS, DOWN BREAKBACK
-A-2 25x25 PLASTIC CONES
-8-8 METALLIC WADERS
ALL PRODUCTS TO BE INSTALLED IN ACCORDANCE WITH SUPPLIER/MANUFACTURER SPECIFICATIONS.

GENERIC NOTES:
1. DO NOT PLACE BACKFILL AROUND CONCRETE TANK UNTIL APPROX 28 DAYS AFTER CONCRETE WALLS & SUSPENDED SLAB HAS BEEN POURED AND CONCRETE TEST RESULTS HAVE BEEN REVIEWED AND APPROVED BY VAN DEN BRINK ENGINEERING LTD.
2. ONCE APPROVAL HAS BEEN GIVEN BY VAN DEN BRINK ENGINEERING TO BACKFILL AROUND THE TANK, BACKFILL IS TO BE PLACED IN MAXIMUM 800mm DEEP LIFTS, GEOTECHNICAL ENGINEER MAY REQUIRE SMALLER LIFTS, BACKFILLING EQUALLY ON ALL SIDES OF THE TANK.
3. MAXIMUM DEPTH OF WATER IS PERMITTED IN THE TANK IF HEIGHT OF BACKFILL AROUND THE TANK IS NOT AT LEAST AS HIGH AS THE LEVEL OF THE WATER ON THE INSIDE OF THE TANK.
4. SEE S1.0 & THIS DRAWING FOR GENERAL NOTES, INCLUDING MATERIAL SPECIFICATIONS AND REQUIREMENTS.
5. NO PLUMBING OR MECHANICAL PIPES ARE TO PASS UNDER ANY STRIP OR TWO FOOTING WITHOUT PRIOR APPROVAL FROM VAN DEN BRINK ENGINEERING LTD.
6. ALL HOODED AND UN-SHAPE DOWNELS TO BE TIED IN PLACE PRIOR TO PLACING CONCRETE.
7. PAD FOOTINGS TO BE CONTROLLED BELOW PRECASTS U.M.G.
8. FOR WOOD FRAME WALL ANCHORAGE REQUIREMENTS, REFER TO DETAILS AND FRAMING SCHEDULES. IT IS STRUCTURALLY ACCEPTABLE TO USE SET-SET ANCHOR BOLTS. ALL HOLD-DOWNS TO BE TIED IN PLACE PRIOR TO PLACING CONCRETE.
9. ALL METAL CONNECTIONS OR EXTENSION OF BRACING OR IN CONTACT WITH PRESSURE TREATED LAMBER TO BE HOT DIPPED GALVANIZED OR STAINLESS STEEL.
LEGEND:
A.F. - ALTERNATE FACE
C.F. - EACH FACE
F.F. - FAN FACE
B.L. - NEW UPPER LAYER
T.L. - TOP UPPER LAYER
B.L. - NEW LOWER LAYER
T.L. - TOP LOWER LAYER
P. - PAVED
F. - PAD FOOTING
H.E. - HOODED 1 END
H.E. - HOODED 2 ENDS
CONC. - CONCRETE
B.L. - NEW UPPER LAYER
T.L. - TOP UPPER LAYER
P. - PAVED
U.M.G. - UNLESS NOTED TO BE THICK

DRAWING INDEX:

S1.0	GENERAL NOTES
S1.0	WATER RESERVOIR TANK ADDITION FOUNDATION PLAN, NOTES & DETAILS
S1.1	WATER RESERVOIR SUSPENDED SLAB PLAN & NOTES

2	REV. B	ISSUED FOR CONSTRUCTION
3	REV. C	ISSUED FOR PERMITS
1	REV. A	ISSUED FOR PERMIT

NO.	DATE	DESCRIPTION	ISSUE



PROJECT:
AQUADEL CROSSING WATER RESERVOIR EXPANSION

1785 COLUMBIA VALLEY ROAD
LABEL BEARD, B.C.

DRAWING TITLE:
WATER RESERVOIR TANK ADDITION SUSPENDED SLAB PLAN & NOTES

PROJECT No.:	17-241
SCALE:	AS NOTED
DRAWN:	DYLAN BOULDERS
CHECKED:	IVAN VAN DEN BRINK
DATE:	MARCH 01, 2018

DRAWING No.	ISSUE
S2.1	3



Telephone: 604 882-8475
Fax: 604 882-8476
general@valleygeo.ca
www.valleygeo.ca

#15 – 20279 – 97th Avenue
Langley, British Columbia
Canada, V1M 4B9

Aquadel Crossing JV
PO Box 2267
Chilliwack, BC V2R 1A6

May 8, 2018

Attention: Mr. Cody Les

Regarding: Reservoir Addition Risk Analysis Hazard Report
1777 Columbia Valley Highway, Cultus Lake, FVRD
Project: 44588-01

1. INTRODUCTION

Valley Geotechnical Engineering Services Ltd. (Valley Geo) has been retained by Aquadel Crossing to complete a Hazard Assessment Report for the proposed water reservoir expansion. This report, with the site plans, summarizes our work to date and presents recommendations pertinent to the proposed reservoir addition (extension) at the subject site.

This report has been prepared in accordance with the Fraser Valley Regional District (FVRD) guidelines for geotechnical reports and hazard assessments, pursuant to Section 56 of the Community Charter and the APEGBC "Guidelines for Legislated Landslide Assessments for Proposed Residential Developments in BC (Revised May 2010)." This report may be used by FVRD Approving Officer for the reservoir addition (extension) building permit approval for a period of two years from the above date.

Based on our review we confirm that the land can be used safely for the use intended provided the recommendations presented in this report are completed. We note that this report only addresses the hazards for the subject site.

2. INFORMATION REVIEWED

Valley Geo previously completed the geotechnical works associated with the original reservoir located on the subject site. This project and several Valley Geo projects in the vicinity were reviewed and referenced in preparation of this report.

- Geotechnical Investigation & Report, Lots 2, 3 Columbia Valley Highway, Lot 4 Frost Road dated October 31, 2018.
- Report Addendum for the Booster Station at 1760 & 1766 Columbia Valley Highway dated August 31, 2011.

- Geotechnical Investigation & Report, 1800 Block Columbia Valley Highway dated December 20, 2007
- Addendum: Geotechnical Recommendations for Proposed Water Reservoir at the 1800 Block of Columbia Valley Highway (Lot 2) dated March 31, 2017
- Excavation, Shoring Installation, and Wall Construction for the Existing Reservoir

In addition to the above, the following external documents were also reviewed:

- Online Aerial Photos (Google Maps & Earth)
- FVRD online Mapping System
- Hazard Acceptability Thresholds for Development Approvals by Local Government by Dr. Peter W. Cave dated 1993
- UBC Surficial Geology Maps

3. SITE DESCRIPTION

Valley Geo completed a site reconnaissance on April 26, 2018 and desktop study for the subject site and surrounding area.

The site consists of a rural property located at 1777 Columbia Valley Highway in the Fraser Valley Regional District with a legal description as follows:

- Plan BCS3022 Section 10 and 15 Township 22 NWD

The site is irregularly shaped with approximate dimensions of 115.73m (N-S) and 95.56m (E-W). A reservoir exists on the site and services the local subdivisions below. As part of the original construction a combined temporary and permanent shotcrete wall was constructed to retain the upper slopes to the south. The shotcrete wall extends approximately 4m below the finished grade surrounding the existing reservoir. A gravel road with flat turn-around provides access for the existing reservoir.

The site is surrounded by rural properties to the west and east and a recent cabin development to the north and Frost Road the south. The site slopes range from 60% above the reservoir to 25% below the reservoir towards the north and north-east. The majority of the site is vegetated with mature coniferous and deciduous growth. Several trees are slightly pistol butt indicating minor surficial creep.

The slopes south of the subject site generally plateau outside of the Frost Road right-of-way. The slopes to the north of the subject site range from 25% to relatively flat in the valley bottom. Immediately south of Frost Road, localized steeper slopes were observed during our site review. This suggests fill may have been placed in this area. The site is located approximately 1km from the nearest mountain that may be subject to an avalanche hazard.

A road side ditch is located on the south side of Frost Road. A 500mm culvert under the road discharges the collected water on the road right-away which flows onto the subject site. Minor erosion channels were observed in the north-east direction away from the existing reservoir.

Frost Creek is located well below the reservoir location at the toe of the slopes. No other notable water courses were observed during our site reconnaissance.

See Appendix A attached for a site location and survey plans.

4. PROPOSED DEVELOPMENT

It is proposed to construct an 8.05m by 7.40m addition at the north-west corner of the existing reservoir. The addition is generally confined to the existing flatter area at the end of the access road.

See Appendix B for the addition civil drawings completed by Wedler Engineering.

5. SOIL CONDITIONS

The Surficial Geological Map Survey of Canada (Map 1485A) indicates the soil at the site is classified as stream deposits (SAj) mountain stream channel gravel and minor sand, up to 10m thick.

Valley Geo previously completed a test pit investigation on June 17, 2006 as part of the existing reservoir geotechnical report. In addition, the soil conditions encountered during the existing reservoir excavation and shotcrete placement encountered were referenced in preparation of this report. The soil conditions generally consist of the following:

- 0.3m of topsoil with roots over
- 0.6m of brown medium dense fine silty sand over
- Loose to medium dense (possibly colluvium) sub-rounded to angular sandy silt to silty sand matrix was encountered to depths explored.

Weak shale like rock was encountered in the vicinity at depth underlying the above profile. No free water was encountered during any work completed on or in the vicinity of the site.

6. SLOPE STABILTY

As part of the hazard review a slope stability analysis was completed. The slope stability analysis was carried out using Slope/W program with limit equilibrium analysis using Morgenstern-Price's Method. The analysis is based on 2012 BC Building Code (BCBC) and the APEGBC's "Guidelines for Legislated Landslide Assessments for Proposed Residential Developments in BC (revised in May 2010)". Requirements for a "safe" slope consist of the following:

- Static factor of safety greater than 1.5, and
- Under seismic conditions;
 - a. Factor of safety greater than 1.0, or
 - b. Horizontal displacements along the slip surface of 15cm or less.

The results of stability analysis indicate that from a global perspective the slopes have the required factors of safety and fall with the required design criteria under both static and seismic conditions. However, minor localized surficial sloughs may occur if the topsoil becomes saturated or with loss of root structure.

See the slope analysis plots attached as Appendix C.

7. HAZARDS AND MITIGATION

Valley Geo has reviewed the site for potential hazards as summarized in the Community Charter. The hazard levels were compared to the acceptable hazard levels as summarized in the Hazard Acceptability Thresholds paper by Dr. Peter W. Cave for an extension.

During our site reconnaissance and desktop review, no rock bluffs or evidence of debris floods was observed. The site is located 1km from the nearest mountain that may be subject to avalanche hazard. The site is well above any creeks that may be subject to flooding or avulsion.

We have therefore concluded that the following hazards to not exist:

- Inundation by Flood Waters
- Mountain stream erosion and avulsion
- Snow Avalanche
- Rock Fall
- Debris Flood

Due to the hillside slopes in the vicinity and uncontrolled water discharge from the culvert under Frost Road, the hazards that may affect the proposed development include:

- Landslides, Small Scale, Localized
- Major Catastrophic Landslide
- Debris Floods, Debris Flows, and Debris Torrents

The following summarizes our review, probability of occurrence, remedial recommendations, and covenant requirements. A Geo-Hazard Assurance Statement is attached as Appendix D.

7.1 Landslides, Small-Scale, Localized (Static)

Slopes up to 1.5 horizontal to 1 vertical exist above the reservoir and 4 horizontal to 1 vertical below the reservoir and generally heavily vegetated. Several pistol-butt trees were observed indicating localized creepage. There is a potential for surficial failures during saturated conditions from extended rainfall, from the culvert under Frost Road, or loss of root structure. We estimate an unmitigated annual probability of damage of 1:500 – 1:10,000.

The proposed addition is located outside the runout of any small surficial sloughs and the grades below the culvert are to the north-east and any failures would be directed away from the addition. The root structure of the trees is essential for maintaining the strength of the upper soils and must not be disturbed to minimize the risk of surficial sloughing.

Based on the above, we estimate a probability of damage to the reservoir addition due to small scale localized landslides to be <1:10,000.

7.2 Major Catastrophic Landslide

Valley Geo has reviewed the surrounding topography, soil conditions, and available online aerial photos. To the best of our knowledge there have not been any large-scale slippages or slides in the area and no evidence of historical slides was observed that may affect the reservoir addition location. However, due to the lack of past studies and monetary restraints for a full analysis, we are unable to entirely rule out the risk of a major landslide.

On this basis, we estimate the annual probability of hazard from a Massive and Catastrophic Landslide to be 1:1,000 to 1:10,000.

7.3 Debris Flows, and Debris Torrents

No creeks subject to debris flooding and torrents are located in the vicinity of the subject site. However, a culvert draining the Frost Road road-side ditch discharges onto the subject site. Several minor erosion channels were observed during our site reconnaissance. Currently, the flow is generally directed away from the proposed reservoir location.

It is our experience that erosion from uncontrolled discharge onto slope of this magnitude is unpredictable and may change. In addition, the current building permit application has no ability to control any increase of flows from future development or drainage re-alignments.


For this reason, we are unable to rule out this hazard entirely. On this basis we estimate the annual probability of hazard from debris flows and torrents to be 1:500 – 1:10,000.

8.0 CONCLUSIONS AND CLOSURE


Valley Geo has concluded that the subject site is safe for the use intended provided the annual probabilities of hazards are understood by all parties involved. We should be given an opportunity to review any changes to the building layout and provide additional recommendations, if required.

We trust that this hazard assessment report provides you with information required for the permit process. If you have any questions, please do not hesitate to call.

Yours very truly;

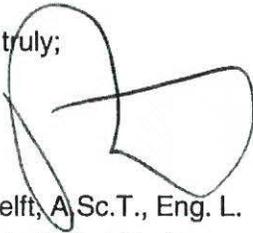

Brad VanDelft, A.Sc.T., Eng. L.
Senior Geotechnical Engineer – Principal

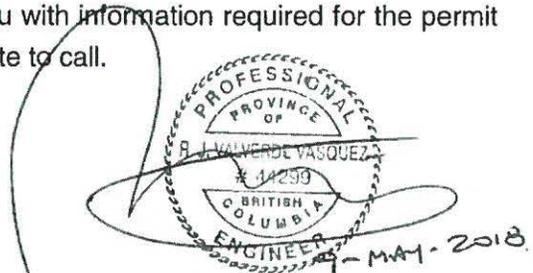

Raul Valverde, P.Eng.
Principal Engineer



Joel Blanco, P.Eng.
Senior Geotechnical Engineer

LIST OF ATTACHMENTS:

- Appendix A: Site Location and Survey Plans
- Appendix B: Addition Civil Drawings
- Appendix C: Slope Analysis
- Appendix D: Geo-Hazard Assurance Statement

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Appendix A
Site Location and Survey Plans

SITE PLAN OF SELECTED TOPOGRAPHIC FEATURES

ON: PART OF COMMON PROPERTY STRATA PLAN BCS3022 SECTION 10 AND 15 TOWNSHIP 22 NEW WESTMINSTER DISTRICT


SCALE 1 : 300

 ALL DISTANCES ARE IN METRES AND DECIMALS THEREOF
 THE PRINTED PLOT SIZE OF THIS PLAN IS 500mm IN WIDTH
 BY 432mm IN HEIGHT (C. SIZE) WHEN PLOTTED AT A SCALE OF 1:300

ADDRESS: 1777 COLUMBIA VALLEY ROAD

LEGEND:

 SPOT ELEVATION

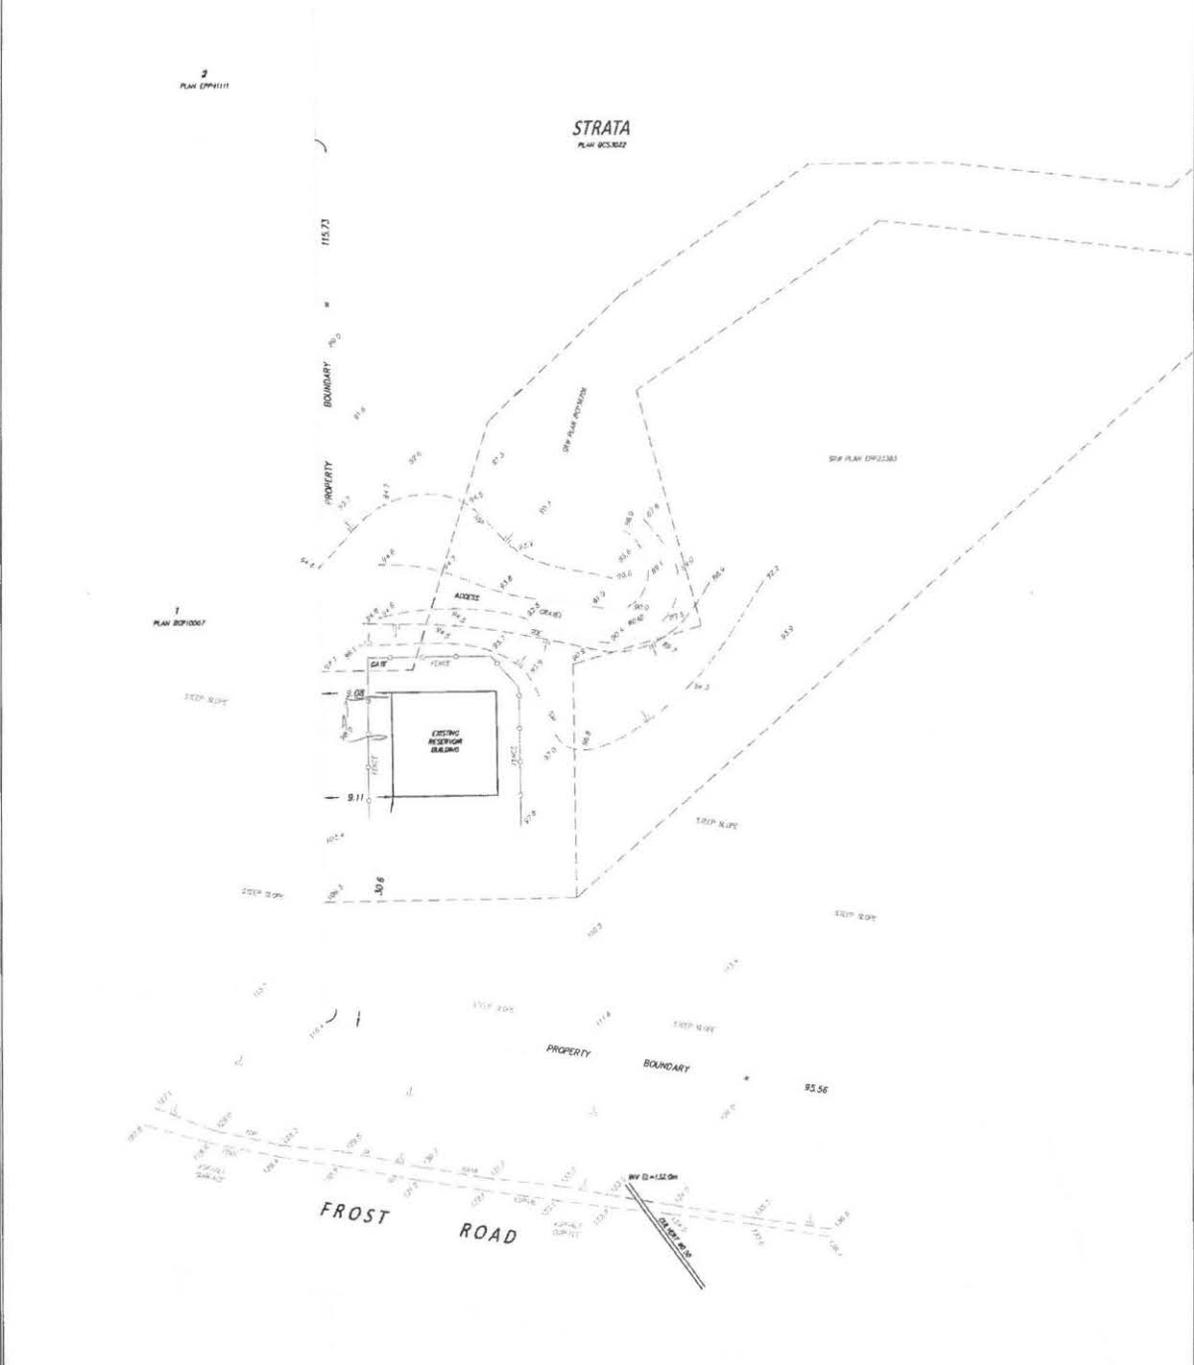

NOTES
 1. THIS PLAN IS PREPARED FOR ARCHIVAL PURPOSES ONLY
 IT IS NOT TO BE USED FOR PROPERTY LINE RE-ESTABLISHMENT
 2. ELEVATIONS ARE QUANTIC, SHOWN IN METRES, AND ARE
 DERIVED FROM GPS OBSERVATIONS
 SATINE CONCRETE

DATED THIS 25TH DAY OF APRIL, 2018


RANDY ARNOLD, BCLS
 THIS DOCUMENT IS NOT VALID UNLESS
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PARCEL 70
 REFERENCE PLAN 12214

A
 2018/04/25
 PLAN 3024

ARNOLD & ASSOCIATES
 B.C. LAND SURVEYORS
 29446 COLUMBIA VALLEY DR. ABSTONTSFORD BC V4W 1L2
 PHONE: 604-651-0511
 604-216-8448
 EMAIL: SURV@ARNOLDAS.COM
 FILE 18302_5

Appendix B
Addition Civil Drawings

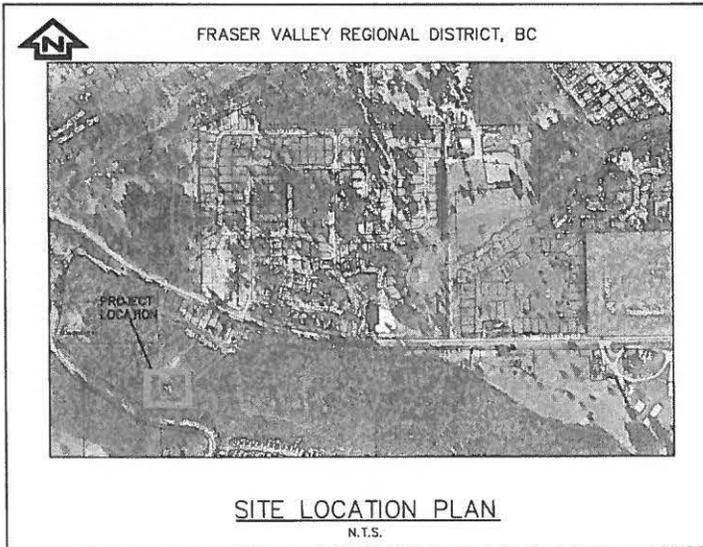

Drawing Index: Rev #1

Drawing No.	Revision	Title of Drawing
		COVER SHEET
C16-5365D-01	A	STANDARD NOTES
C16-5365D-02	A	WATER CONTEXT PLAN
C16-5365D-03	A	RESERVOIR SITE PLAN

DRAWING INDEX
REVISION #1

Client:

AQUADEL CROSSING JOINT VENTURE

Project:

AQUADEL CROSSING
WATER RESERVOIR EXPANSION
1777 COLUMBIA VALLEY ROAD

Engineering Services Provided by:



WEDLER
ENGINEERING

www.wedler.com

THE WEDLER GROUP


- Abbotsford
1.604.746.0300
- Chilliwack
1.604.792.0651
- Courtenay
1.250.334.3263
- Surrey
1.604.588.1919

PRELIMINARY

Project No: C16-5365/D
Date: JANUARY 2018
ISSUED FOR PERMITTING



LOCAL GOVERNMENT FILE: SUB

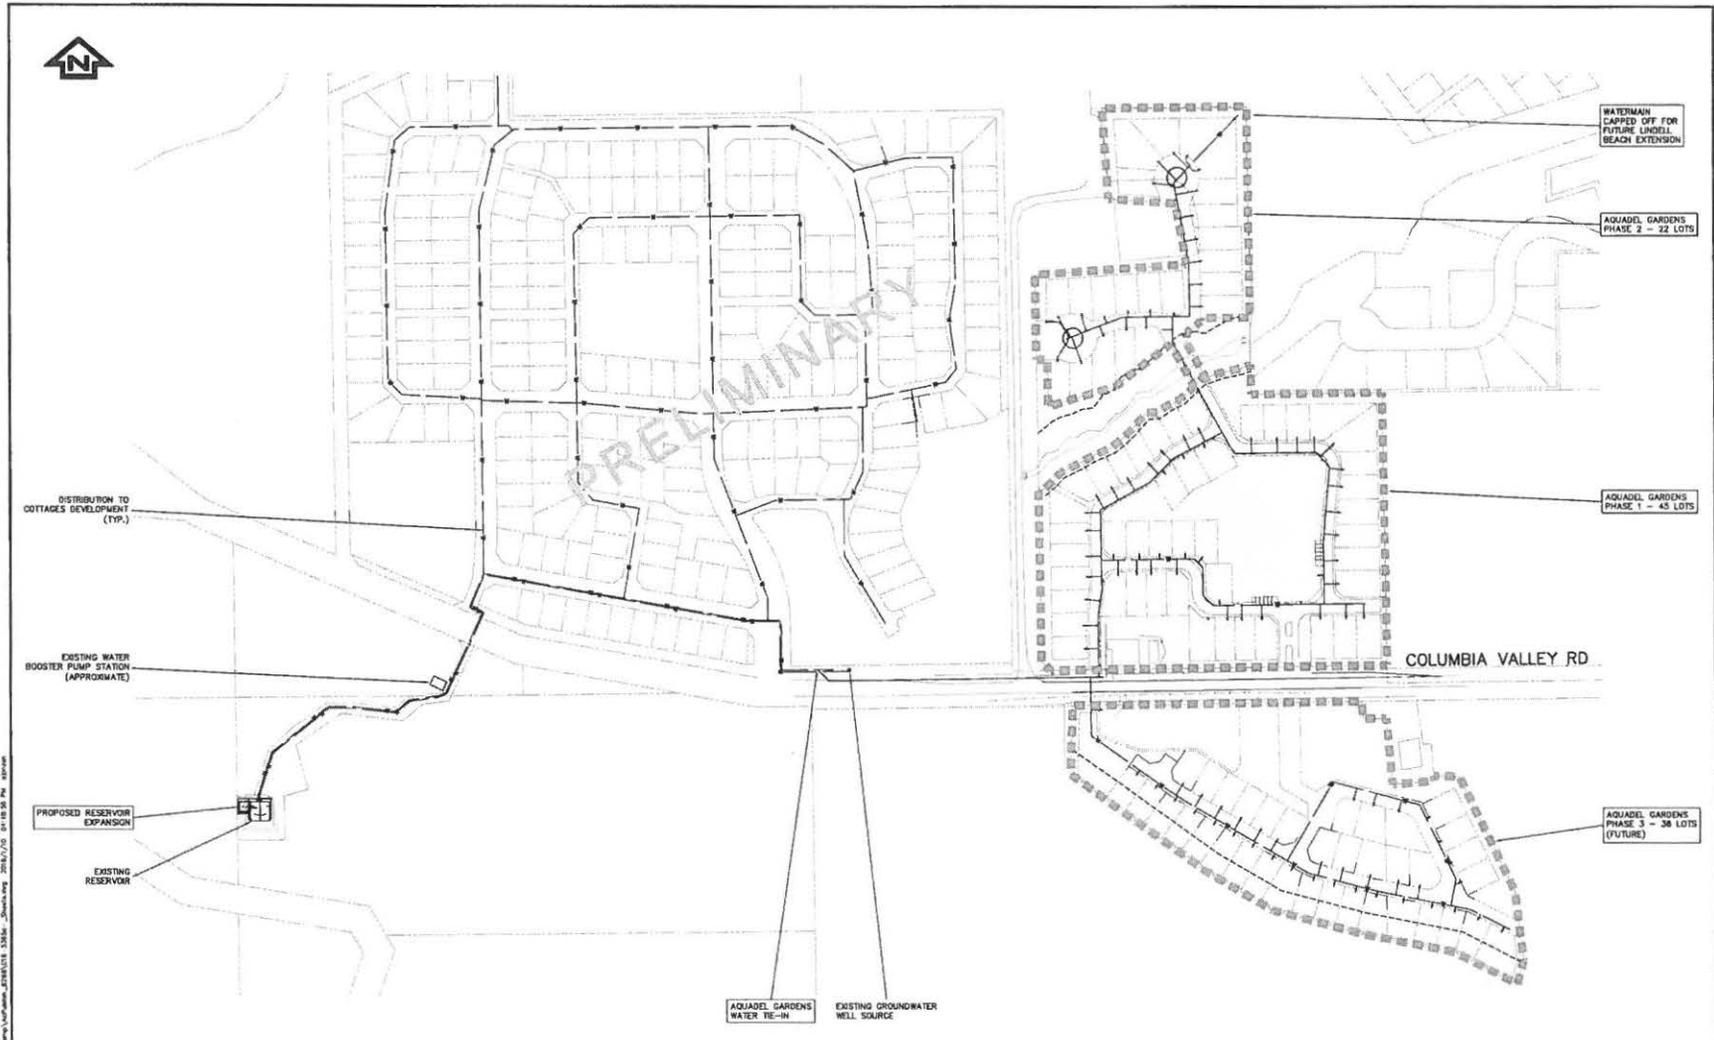

REV	DESCRIPTION	DATE	BY	CHK
1	ISSUED FOR PERMITTING	2016-01-10	JAM	

PERM. NO.	ZT
DESIGNED BY	JAM
PERM. NO.	
SCALE	1:1000
DATE	





- THE WEDLER GROUP
- Architects
 - Engineers
 - Civil/Structural
 - Environmental
 - Survey

AQUADEL CROSSING JOINT VENTURE
WATER RESERVOIR EXPANSION
LINDELL BEACH, BC
WATER CONTEXT PLAN

DRAWING NO.	07-3-
	C16-5365/D-02
LOCAL IMPROVEMENT FILE	-FILE-
DATE	REVISION
	A

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PRELIMINARY

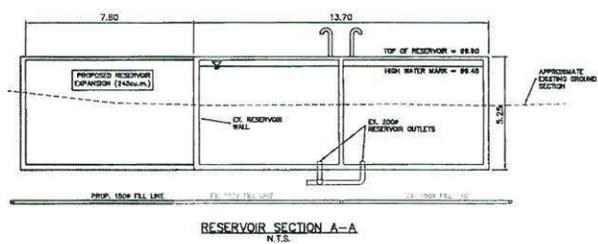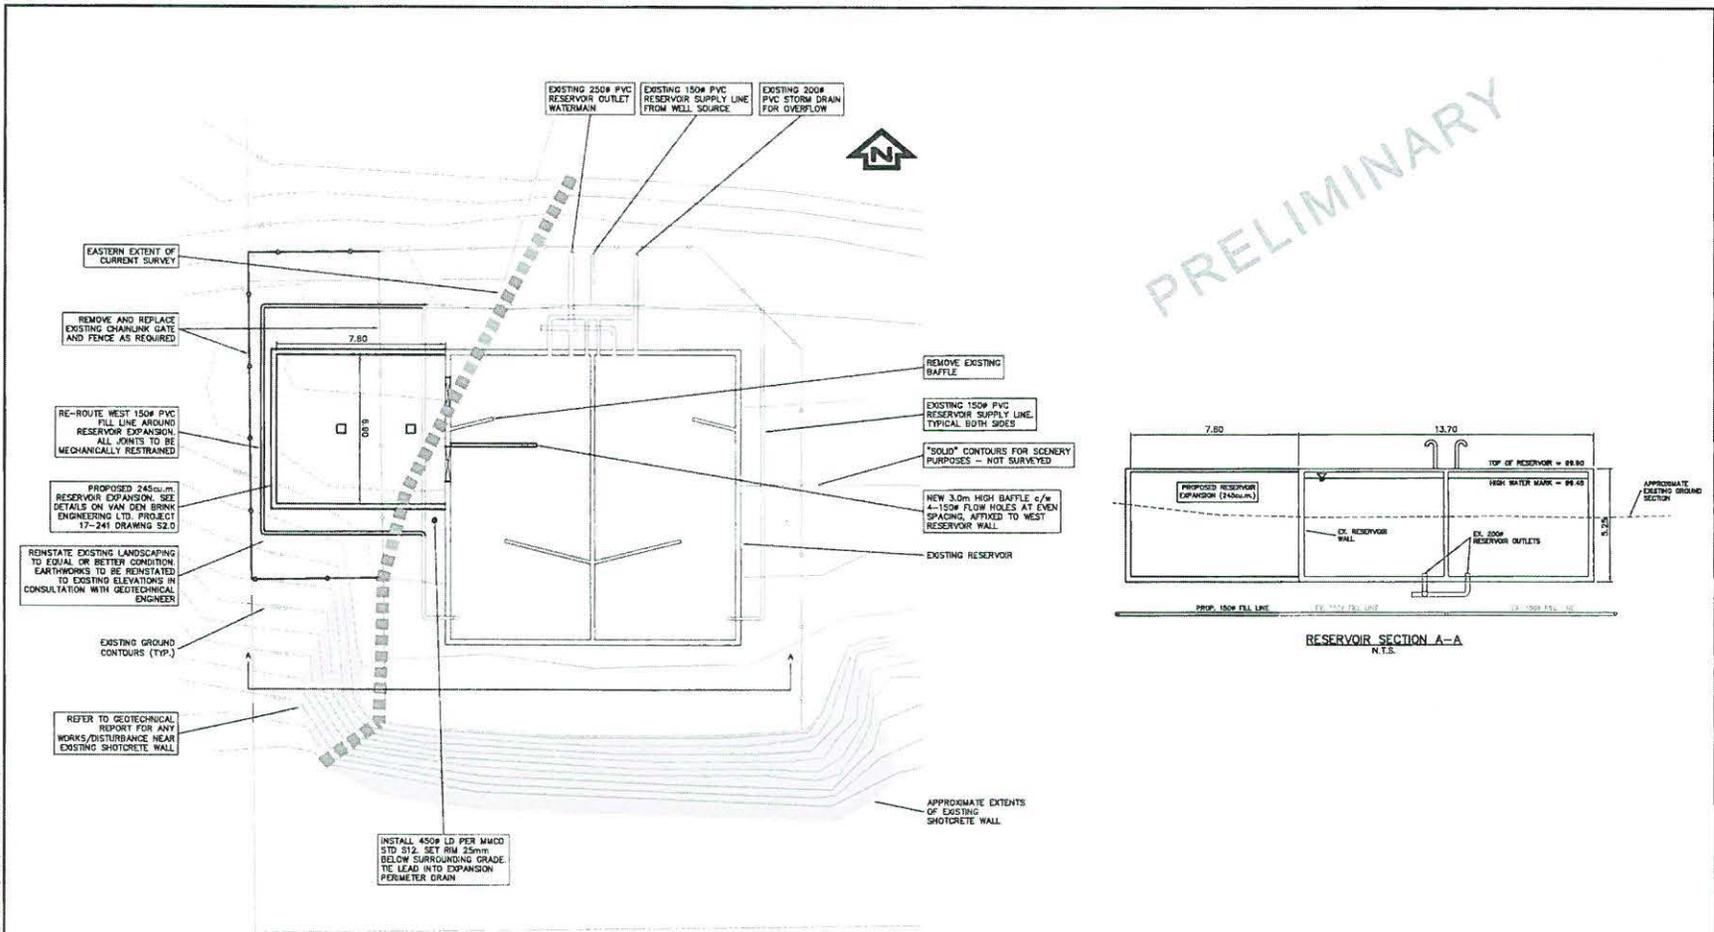

RESERVOIR PLAN DETAILS
1:100

RESERVOIR SECTION A-A
N.T.S.

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C16-5365/D-03	3																																									
LOCAL IMPROVEMENT FILE	FILE																																									
DATE	REVISION																																									
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Appendix C
Slope Analysis

Appendix D
Geohazard Assurance Statement

Geo-Hazard Assurance Statement

for Development Approvals

A. Project Information

Date May 8, 2018 FVRD File No. _____

Property Information

Project Name & Description Reservoir Addition (Extension)
Legal Description Plan BCS3022 Section 10 and 15 Township 22 NWD
Site Address 1777 Columbia Valley Highway PID _____

Client Information

Name Aquadel Crossing Ltd
Role Property Owner Developer Other
Client Address PO Box 2267, V2R 1A6

Qualified Professional Information

Name Raul Valverde
APEGBC Designation P.Eng. P. Geo. Eng.L Geo.L
Company Name Valley Geotechnical Engineering Services Ltd.
Mailing Address #15, 20279 - 97 Avenue, Langley
Email Address _____ Phone # _____

Geo-Hazard Report Reference

Title Reservoir Addition Risk Analysis Report Date May 8, 2018

Personal information on this form is being collected in accordance with Section 27 of the Freedom of Information and Protection of Privacy Act, RSBC 1996 Ch. 165; Part 9, Division 1 [Building Regulation] and Part 14 [Planning and Land Use Management] of the Local Government Act, RSBC 2015 Ch. 1; and Section 56 of the Community Charter, SBC 2003 Ch. 26 and will only be collected, used and disclosed for the purpose of administering geo-technical hazard reviews and assurance statements related to development approvals. Questions? Contact FVRD Privacy Officer at 45950 Cheam Avenue, Chilliwack, BC V2P 1N6; 604-702-5000 or 1-800-528-0061; or FOI@fvrd.ca.



Geo-Hazard Assurance Statement

for Development Approvals

B. Assurance

Based on the contents of this Assurance Statement and the Report, I hereby give assurance that:
(check as applicable)

<input type="checkbox"/>	Development Permit	The Report will "assist the local government in determining what conditions or requirements under it will impose in the permit", as required by the <i>Local Government Act</i> (Division 7)
<input checked="" type="checkbox"/>	Building Permit	
	<input checked="" type="checkbox"/> Community Charter	"The land may be used safely for the use intended", as required by the <i>Community Charter</i> (Section 56)
	<input checked="" type="checkbox"/> Seismic Slope	The Report addresses the requirements of the BC Building Code 2006, 4.1.8.1.6 (8) and 9.4.4.4 (2), as detailed in the BC Building & Safety Policy Branch Information Bulletin B10-01, Jan 18, 2010
<input type="checkbox"/>	Floodplain Management Bylaw Exemption	"The land may be used safely for the use intended", as required by the <i>Local Government Act</i> . (Section 524)
<input type="checkbox"/>	Subdivision	"The land may be used safely for the use intended", as required by the <i>Land Title Act</i> (Section 86).
<input type="checkbox"/>	Other (e.g. Zoning Bylaw Amendment, Official Community Plan Amendment, Temporary Use Permit, etc.)	<Insert statement as appropriate>

C. APEGBC Professional Practice Guidelines

The Report and this Assurance Statement should be completed in accordance with the current version of one or both of the following Professional Engineers and Geoscientists of BC (APEGBC).

- *Legislated Flood Assessments in a Changing Climate in BC*
- *Legislated Landslide Assessments for Proposed Residential Development in British Columbia, ("APEGBC Landslide Guidelines")*.

These two documents are collectively referred to as the "APEGBC Guidelines". The italicized words in this Assurance Statement are defined in the APEGBC Guidelines.

The Report has been prepared pursuant to the following APEGBC Guidelines (check one or both as applicable).

- APEGBC Flood Guidelines
- APEGBC Landslide Guidelines

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If the Report is not prepared pursuant to either of the APEGBC Guidelines, please explain.

D. Background Information

Qualified Professionals **must** confirm and check that each item is included in the Report.

- 1. Property location map — 8.5 x 11 size
- 2. Development proposal site plan — 8.5 x 11 size. *If a subdivision, show the parent parcel and all lots to be created, including any remainder.*
- 3. Description of the proposed development project (including building use) to the extent this is known at the time of Report preparation.
 - residential
 - industrial
 - commercial
 - institutional
 - other water reservoir

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E. Technical Requirements

Qualified Professionals **must** review, confirm and check completed items (as applicable).

Report Content

- 4. Relevant information pertaining to the Property and pertinent potential hazards from appropriate background sources, including the FVRD online library.
- 5. Time limitation or condition statement to describe extent the FVRD may rely on the Assurance Statement and Report for development approvals, and when resubmittal is recommended.
- 6. Maps, illustrations and diagrams to illustrate areas referred to in the Report.
- 7. Description of field work conducted on and, if required, beyond the Property.
- 8. Contact and consultation with the Fraser Valley Regional District. Provide name and title of contact.
FVRD Planner - Mike Foster
- 9. Review of relevant FVRD bylaws and other statutory requirements.
- 10. Restrictive covenants registered against the Property title that pertain to geo-hazards (if registered, the Report provides relevant information about the covenants).
- 11. Notation of any visibly apparent natural hazards or other hazards identified in background reports, which are not identified and addressed in this Report. If yes, provide details in Section H: Geo-Hazard Summary Table.
 - Yes
 - No
- 12. Does the report rely on one or more supporting reports, each of which is independently reviewed, signed and sealed. If yes, provide details in Section H: Geo-Hazard Summary Table.
 - Yes
 - No
- 13. For subdivision approval, the Report addresses natural hazards for:
 - the parent parcel prior to subdivision
 - any lots to be created (including any remainder)

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Geo-hazard Assessment, Risk Acceptability and Risk Transfer

- 14. In considering the above-noted potential hazards that may affect the property, I have:
 - reviewed and characterized the potential hazard(s)
 - estimated the potential frequency and magnitude of the potential hazard(s)
 - relied on supporting reports as noted above
 - relied on a pre-existing assessment of hazard frequency and magnitude
 - considered the potential effects of climate change in the context identified in the Report
 - considered the potential effects of changed future conditions (upstream watershed changes, forestry activity, land use changes, sea level rise, etc.) in the context identified in the Report
- 15. This Assurance Statement pertains to all geo-hazards that are assessed in the Report and any supporting reports, and accurately reflects the contents of those documents.
- 16. The FVRD has adopted "Hazard Acceptability Thresholds for Development Approvals by Local Government", which provides a specific level of hazard or risk tolerance. I have included a Hazard Summary Table which:
 - lists all the potential hazards addressed by the Report and any supporting reports
 - provides an annual return frequency and acceptability threshold classification for the unmitigated condition
 - proposes mitigative measures to appropriately reduce the geo-hazard risk
 - provides an annual return frequency and acceptability threshold classification for the mitigated condition
- 17. The Report describes the potential transfer of natural hazard risk to other properties or infrastructure as a result of the proposed project (including any proposed *mitigation works*) and
 - considered the potential for transfer of natural hazard risk
 - concludes that there is no significant transfer of natural hazard risk
 - identifies the potential transfer of natural hazard risk and proposes measures to offset such transfer of risk

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Mitigation and Design Recommendations (if recommended)

The Report contains the following items:

- 18. Implementation steps for the identified structural mitigation works (in terms of design, construction and approval).
- 19. Clearly identified safe locations for building(s), ancillary structures, and onsite utility services (as applicable, such as a septic field) out of the natural hazard area as a preferred development alternative.
- 20. Commentary on the effectiveness of proposed structural mitigation works in terms of ability to reduce the potential hazard impact, and identification of any residual risk that would remain.
- 21. Proposed Flood Construction Level (FCL) for future development and including specification of an appropriate method of achieving the FCL.
- 22. Proposed watercourse setback, which is clearly referenced from the natural boundary, top of bank or another suitable basis.
- 23. Proposed operation and maintenance actions that will be necessary in order for the level of safety to be maintained in the future, with indications of who should be responsible for those actions and when.

Riparian Area Regulation (if applicable)

- 24. QP must review RAR assessment report to avoid conflict with Geo-Hazard Report recommendations.

F FVRD Supplemental Requirements

The following points are understood by the Qualified Professional when submitting a Report:

- 25. Permission is granted to the FVRD to use the Report in considering approval of the proposed development on the property, provided that such permission is limited only to the proposed development project for which the Report was prepared.
- 26. Methodology used in the Report is described in sufficient detail to facilitate a professional review of the study by the FVRD when necessary.
- 27. Professional liability insurance coverage of at least \$1 million per claim is carried by the QP.
- 28. Third party review or supplemental information may be required by the FVRD where complex development proposals warrant.
- 29. Permission is granted to the FVRD to include the Report in the online FVRD geo-hazard report library (as background information, not for other parties to rely).

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G. Qualified Professional (QP)

Prepared by: (QP of Record)

Name Raul Valverde

Designation P.Eng. P. Geo. Eng.L Geo.L

Reviewed by:

Name Joel Blanco

Designation P.Eng. P. Geo.

The Report has received appropriate technical review which is consistent with both the APEGBC Professional Practice Guidelines, and APGBC Quality Management Guidelines. The name of the reviewer is noted in the Report and below.

Professional Seal, Signature and Date:



- I am a Qualified Professional as defined in the APEGBC Guidelines, and I fulfill the education, training and experience requirements as outlined in the APEGBC Guidelines
- I have signed, sealed, dated and thereby certify, this Assurance Statement and the attached report.

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H. Geo-Hazard Summary Table

The geo-hazard report and/or any supporting reports addresses the following hazard types.

Geo-Hazard Type #1 Small Scale Localized Landslip		Geo-Hazard Type #2 Major Catastrophic Landslide	
Annual Return Frequency (Unmitigated) 1:500 - 1:10000		Annual Return Frequency (Unmitigated) 1:1000 - 1:10000	
Acceptability Threshold Classification	3	Acceptability Threshold Classification	2
MITIGATION (if necessary)			
Proposed Mitigation Measures	Yes <input checked="" type="radio"/> No <input type="radio"/>	Proposed Mitigation Measures	Yes <input type="radio"/> No <input checked="" type="radio"/>
Annual Return Frequency (Mitigated) <10000		Annual Return Frequency (Mitigated)	
Acceptability Threshold Classification	1	Acceptability Threshold Classification	
Comments		Comments	
SUPPORTING REPORT			
Was this report prepared by others?	Yes <input type="radio"/> No <input checked="" type="radio"/>	Was this report prepared by others?	Yes <input type="radio"/> No <input checked="" type="radio"/>
If yes, list report name, date and author.		If yes, list report name, date and author.	

Geo-Hazard Type #3 Debris Flow and Debris Torrent		Geo-Hazard Type #4	
Annual Return Frequency (Unmitigated) 1:500 - 1:10000		Annual Return Frequency (Unmitigated)	
Acceptability Threshold Classification	2	Acceptability Threshold Classification	
MITIGATION (if necessary)			
Proposed Mitigation Measures	Yes <input type="radio"/> No <input checked="" type="radio"/>	Proposed Mitigation Measures	Yes <input type="radio"/> No <input type="radio"/>
Annual Return Frequency (Mitigated)		Annual Return Frequency (Mitigated)	
Acceptability Threshold Classification		Acceptability Threshold Classification	
Comments		Comments	
SUPPORTING REPORT			
Was this report prepared by others?	Yes <input type="radio"/> No <input checked="" type="radio"/>	Was this report prepared by others?	Yes <input type="radio"/> No <input type="radio"/>
If yes, list report name, date and author.		If yes, list report name, date and author.	

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Indicate which hazards were NOT reviewed:

- | | |
|--|--|
| <input type="checkbox"/> Chilliwack River Valley Erosion or Avulsion | <input type="checkbox"/> Seismic Effects/Liquefaction |
| <input type="checkbox"/> Debris Flow and Debris Torrent | <input type="checkbox"/> Rockfall - Small Scale Detachment |
| <input type="checkbox"/> Debris Flood | <input type="checkbox"/> Slope Stability |
| <input type="checkbox"/> Fraser River & tributaries flooding | <input type="checkbox"/> Small Scale Localized Landslide |
| <input type="checkbox"/> Mountain Stream Erosion or Avulsion | <input type="checkbox"/> Snow Avalanche |
| <input type="checkbox"/> Major Catastrophic Landslide | <input checked="" type="checkbox"/> Tsunami |

Hazard Acceptability Thresholds Classification, as per Hazard Acceptability Thresholds for Development Approvals by Local Government dated November 1993 by Dr. Peter Cave.

- 1 Approval with conditions relating to hazards.
- 2 Approval, without siting conditions or protective works conditions, but with a covenant including "save harmless" conditions.
- 3 Approval, but with siting requirements to avoid the hazard, or with requirements for protective works to mitigate the hazard.
- 4 Approval as (3) above, but with a covenant including "save harmless" conditions as well as siting conditions, protective works or both.
- 5 Not approvable.

Additional Comments